МЕСЦИ		
	ANICAL SYMBOL LIST	
	NOT ALL SYMBOLS MAY A	APPLY.
SYMBOL:	DESCRIPTION:	
	MANUAL VOLUME DAMPER	
Ł	DUCT CAP	
	DUCT DOWN	
	DUCT UP	
$\square$	SUPPLY/OUTSIDE AIR DUCT SECTION	
	RETURN AIR DUCT SECTION	
	EXHAUST/RELIEF AIR DUCT SECTION	
<u>SG-1</u> 6/115	AIR TERMINAL PROPERTIES	<u>SYMBOL</u> NECK SIZE/CFM
T	THERMOSTAT/SENSOR	
EF	EXHAUST FAN	
EA	EXHAUST AIR	
SA	SUPPLY AIR	
TG	TRANSFER GRILLE	
TD	TRANSFER DUCT	

TAG	M
F-1	
Notes:	
1. PROVID	DE E
2. PROVID	DE 1
3. TRANE	IS B

## **MECHANICAL GENERAL NOTES:**

- 1. ALIGN TEMPERATURE SENSORS WITH LIGHT SWITCHES WHEN IN CLOSE PROXIMITY TO EACH OTHER.
- 2. REVIEW SPACE REQUIREMENTS OF EQUIPMENT SPECIFIED AND MAKE REASONABLE ACCOMMODATIONS IN LAYOUT AND PROVIDE PROPER ACCESS AND CLEARANCES REQUIRED FOR OPERATION, MAINTENANCE, CODE COMPLIANCE.
- 3. SEAL ALL FLOOR, WALL AND ROOF PENETRATIONS AIRTIGHT WHERE DUCT PENETRATE.
- 4. EQUIPMENT SIZES AND SERVICE CLEARANCE REQUIREMENTS VARY AMONG DIFFERENT MANUFACTURERS. COORDINATE WITH LAYOUT OF EQUIPMENT PADS, DUCTWORK ETC.
- 5. MANUFACTURER SHOWN IN SCHEDULE IS BASIS OF DESIGN.
- 6. DUCT CONSTRUCTION SHALL BE IN ACCORDANCE WITH THE LATEST EDITION OF THE SMACNA HVAC DUCT CONSTRUCTION STANDARD.
- 7. COORDINATE DIFFUSER, GRILLE AND REGISTER LOCATIONS WITH ARCHITECTURAL REFLECTED CEILING PLANS AND EQUIPMENT OF ALL TRADES.
- 8. ALL DUCT SIZES SHOWN ARE INSIDE CLEAR DIMENSIONS.
- 9. DAMPERS AND INSIDES OF DUCT VISIBLE THROUGH GRILLES, REGISTERS AND DIFFUSERS SHALL BE PAINTED FLAT BLACK.
- 10. CONDENSATE DRAIN FROM ALL MECHANICAL EQUIPMENT SHALL BE PROVIDED FOR PROPER DRAINAGE TO SUIT EQUIPMENT FURNISHED.
- 11. ALL DUCTWORK SHOWN ARE SCHEMATICALLY. PROVIDE ALL TRANSITIONS, TURNING VANES, ELBOWS, FITTINGS ETC; TO ALLOW SMOOTH FLOWS.
- 12. VERIFY FINISH WITH ARCHITECT PRIOR TO PURCHASING GRILLES, REGISTERS, DIFFUSER AND OTHER AIR DISTRIBUTION DEVICES.

					<b>FURN</b>	ACE S	CHEDU	LE (G	AS HE	ATING	G)				
				SUPP	LY FAN				COOLI	NG COIL		GAS HEATING		ELECTRI	CAL
ИANUFACTURE R	MODEL	NOMINAL TON	SUPPLY CFM	OA CFM	ESP (IN.W.C.)	МНР	RPM	EAT DB (°F)	EAT WB (°F)	LAT (°F)	TOTAL MBH	МВН	МОСР	MCA	vo
TRANE	TUHM100	4	1715	300	0.5	1	VARIABLE	80	67	55	48	48	15	10.4	

ECM BLOWER MOTOR.

1" EXPANDABLE STANDARD EFFICIENCY MEDIA AIR FILTER.

BASIS OF DESIGN. IF DIFFERENT MANUFACTURER IS SELECTED THEN CONTRACTOR NEEDS TO MAKE SURE IT MATCHES WITH THE INTENT OF DESIGN.

		AI	<b>R CONDIT</b>	IONER	SCHEDULE	
TAG	SERVICE	MANUFACTURE R	MODEL	TON	REFRIGERANT TYPE	AMBIENT TEMP. (°F)
AC-1	F-1	TRANE	4TTV0048	4	R-410A	95
NOTES:						

1. TRANE IS BASIS OF DESIGN. IF DIFFERENT MANUFACTURER IS SELECTED THEN CONTRACTOR NEEDS TO MAKE SURE IT MATCHES WITH THE INTENT OF DESIGN.

		0	UTSIDE /	AIR CALC F	-1 (IMC-2019	)	
ROOM NAME	SQ.FT	PEOPLE	CFM/SQFT	CFM/PERSON	TOTAL CFM/SQFT	TOTAL CFM/PERSON	
OPEN AREA	367	0	0.06	0	22.02	0	
DINING ROOM	139	6	0.06	5	8.34	30	
LIVING ROOM	285	6	0.06	5	17.1	30	
BEDROOM 2	113	2	0.06	5	6.78	10	
BEDROOM 1	116	2	0.06	5	6.96	10	
MASTER BEDROOM	151	2	0.06	5	9.06	10	
BEDROOM 4	110	2	0.06	5	6.6	10	
HALLWAY	122	0	0.06	0	7.32	0	
BEDROOM 3	96	2	0.06	5	5.76	10	
					TOTAL	OUTSIDE AIR REQUIRED	
					TOTAL	OUTSIDE AIR PROVIDED	

	GRILL	ES RE	GISTERS	6 & DIFF	USER	S SCHED	ULE
SYMBOL	MANUFACTURE R	MODEL	MATERIAL	INLET SIZE (INCH)	FACE SIZE	MOUNTING LOCATION	FACE TYPE
SG-1	TITUS	300R	STEEL	SEE DWG.	INLET +2	GYP.	DOUBLE DEFLECTION
RG-1	TITUS	350R	STEEL	SEE DWG.	INLET +2	GYP.	35° DEFLECTION
TG-1	TITUS	350R	STEEL	SEE DWG.	INLET +2	GYP.	35° DEFLECTION
NOTES:							

1. ALL RUN OUT DUCTWORK TO DIFFUSERS SHALL BE NECK SIZE UNLESS OTHERWISE NOTED. 2. FRAME TYPE TO MATCH MOUNTING LOCATION CONSTRUCTION MATERIAL. COORDINATE WITH ARCHITECTURAL REFLECTED CEILING PLAN.


		FA	N SCHEDULE			
SYMBOL	MANUFACTURE	MODEL	SERVICE LOCATION	CFM	ELECTRIC	AL
	R				POWER (WATT)	VOLT-PHASE
EF-1	СООК	GC-148	NEW BATHROOM	50	36	115-1
EF-2	СООК	GC-148	BATHROOM BEDROOM 1	50	36	115-1
EF-3	СООК	GC-148	BATHROOM BEDROOM 2	50	36	115-1
EF-4	СООК	GC-148	POWDER ROOM	50	36	115-1
EF-5	СООК	GC-148	MASTER BATHROOM	50	36	115-1
EF-6	СООК	GC-148	BAHROOM BEDROOM 4	50	36	115-1

	HVAC SHEET INDEX	
Sheet Number	Sheet Name	Current Revision
M0.1	MECHANICAL SCHEDULES	
M1.0	BASEMENT AND FIRST MECHANICAL FLOOR PLAN	
M1.1	SECOND AND ROOF MECHANICAL FLOOR PLAN	
M4.1	MECHANICAL DETAILS	
M5.1	HVAC AND GAS RISER	


DLT-PHASE	WEIGHT (LBS)	NOTES
115-1	197	1,2
E VOLT-PH	LECTRICA	L MOCP


L CFM/PERSON TOTAL CFM 22.02 0 30 38.34 30 47.1 10 16.78 10 16.96 10 19.06 10 16.6 0 7.32 10 15.76 AIR REQUIRED 199.94

300

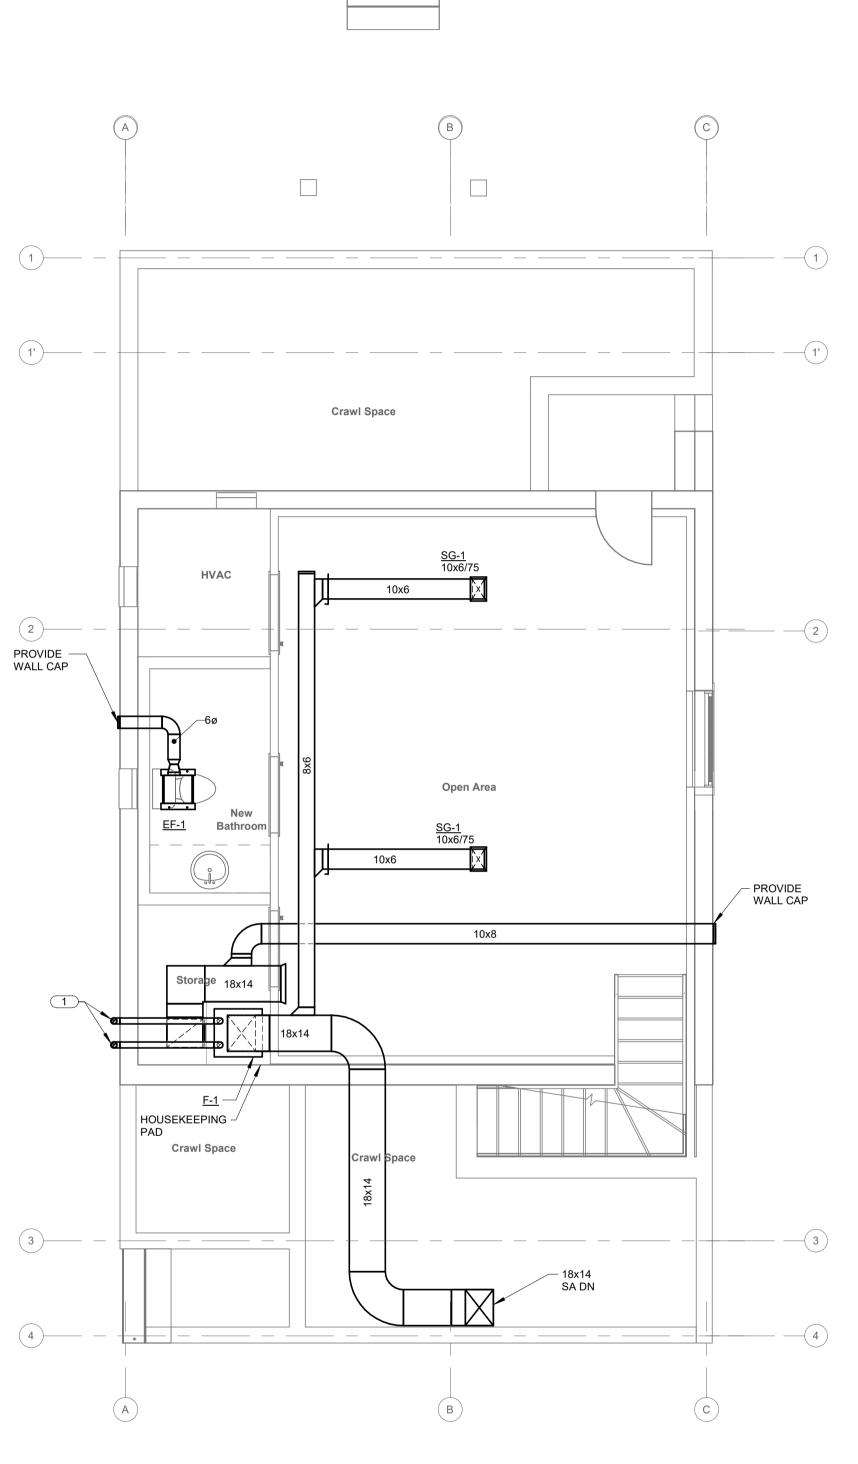


D BASEMENT MECHANICAL FLOOR PLAN 1/4" = 1'-0"

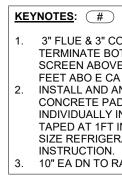


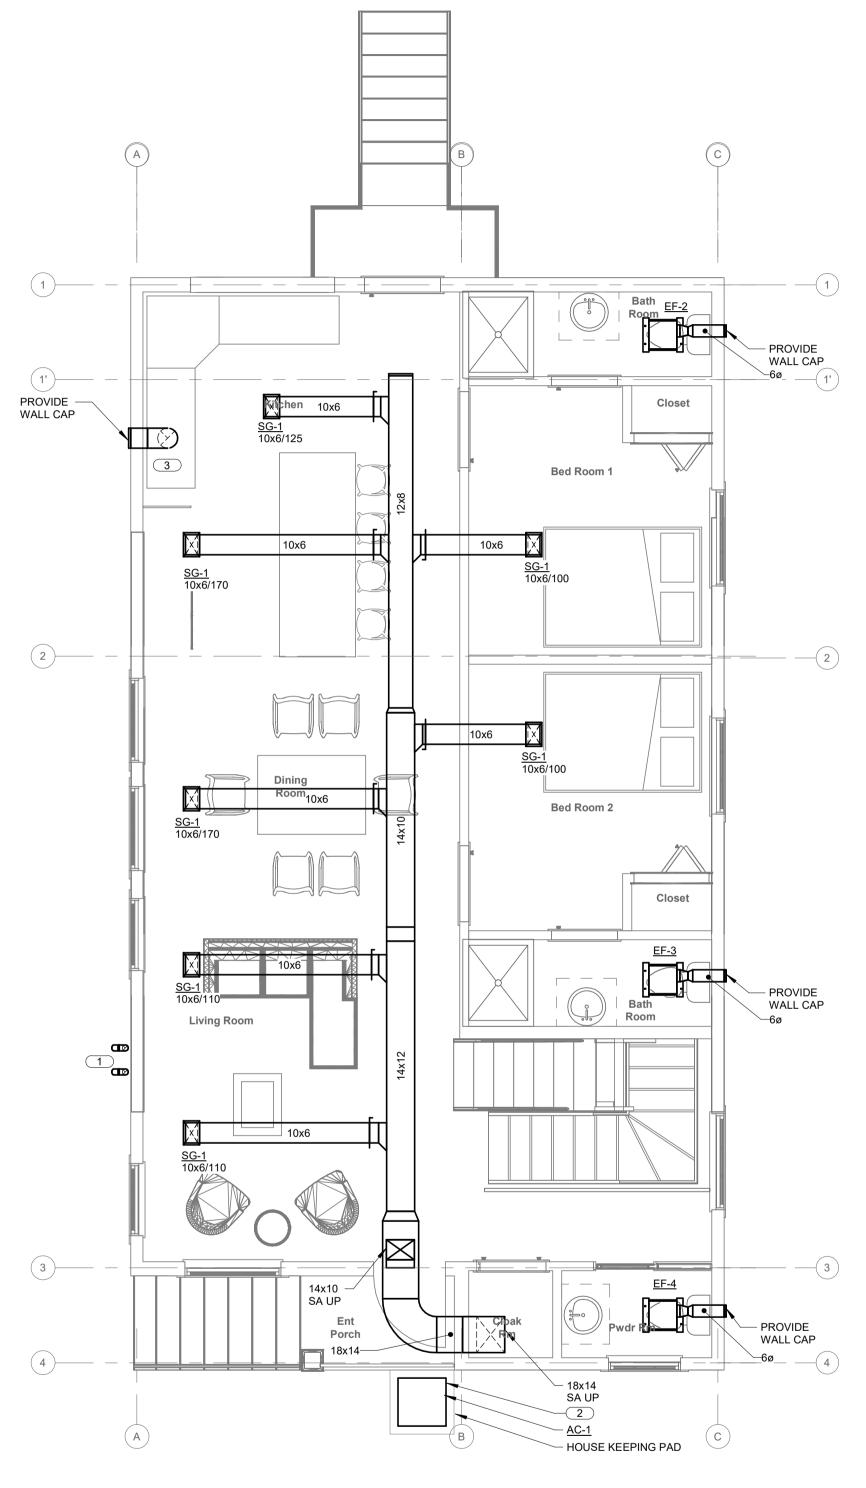

2 LEVEL 1 MECHANICAL FLOOR PLAN 1/4" = 1'-0"

3" FLUE & 3" COMBUSTION AIR (CA) FOR UNIT. TERMINATE BOTH WITH GOOSENECK AND BIRD SCREEN ABOVE GRADE. FLUE SHALL BE AT LEAST 3 FEET ABO E CA PIPE.
INSTALL AND ANCHOR CONDENSING UNIT ON 4" CONCRETE PAD ON THE GROUND. PIPING SHALL BE INDIVIDUALLY INSULATED WITH FIBERGLASS WRAP, TAPED AT 1FT INTERVALS AND ALUMINUM JACKETED. SIZE REFRIGERANT PIPING AS PER MANUFACTURER INSTRUCTION.
10" EA DN TO RANGE HOOD.

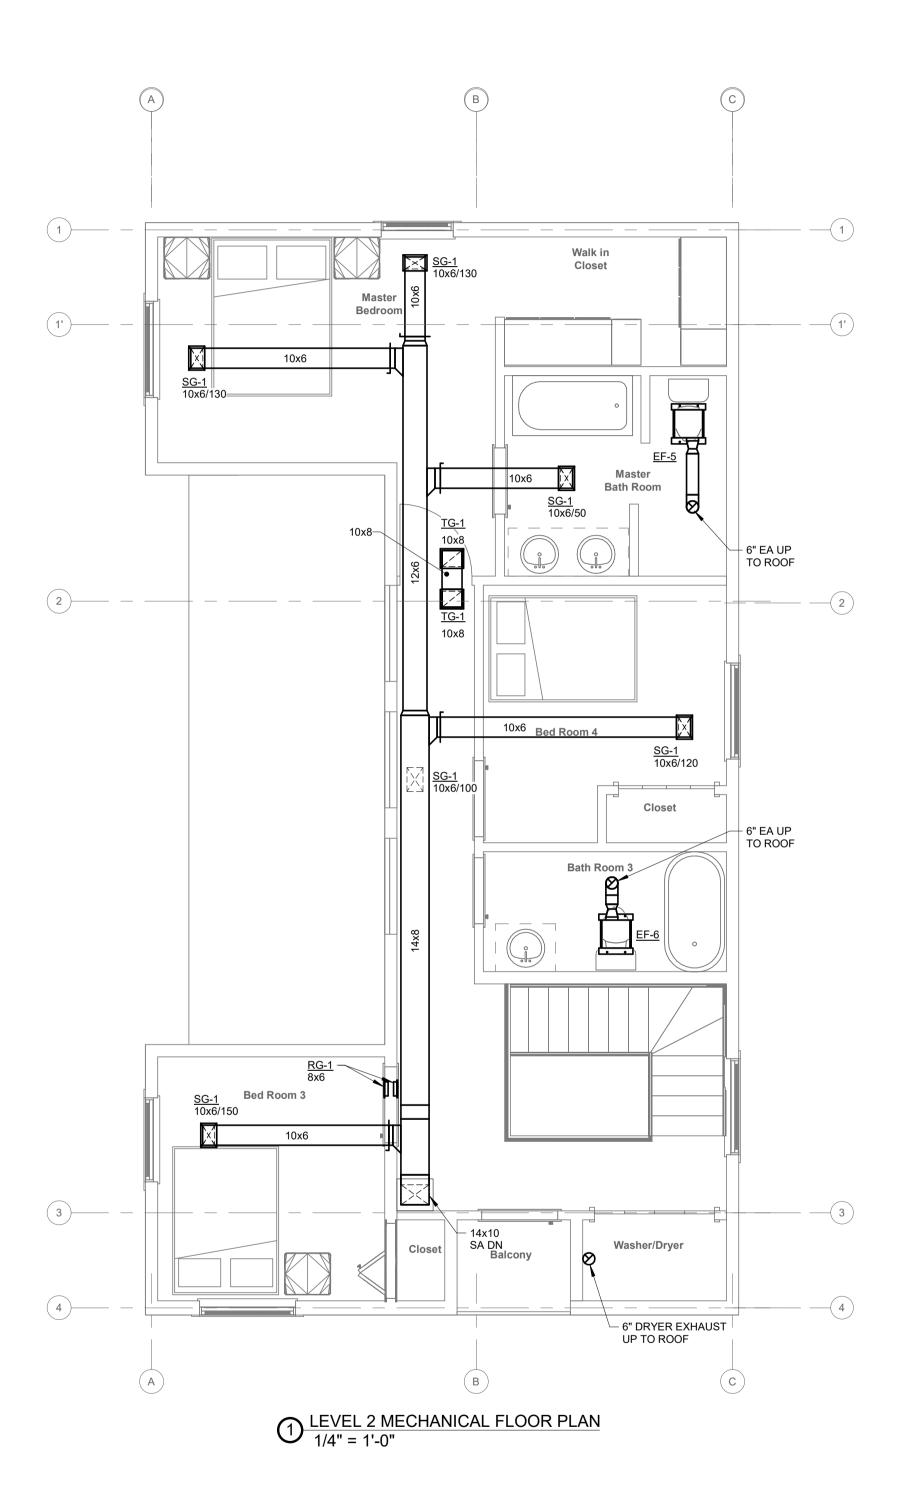

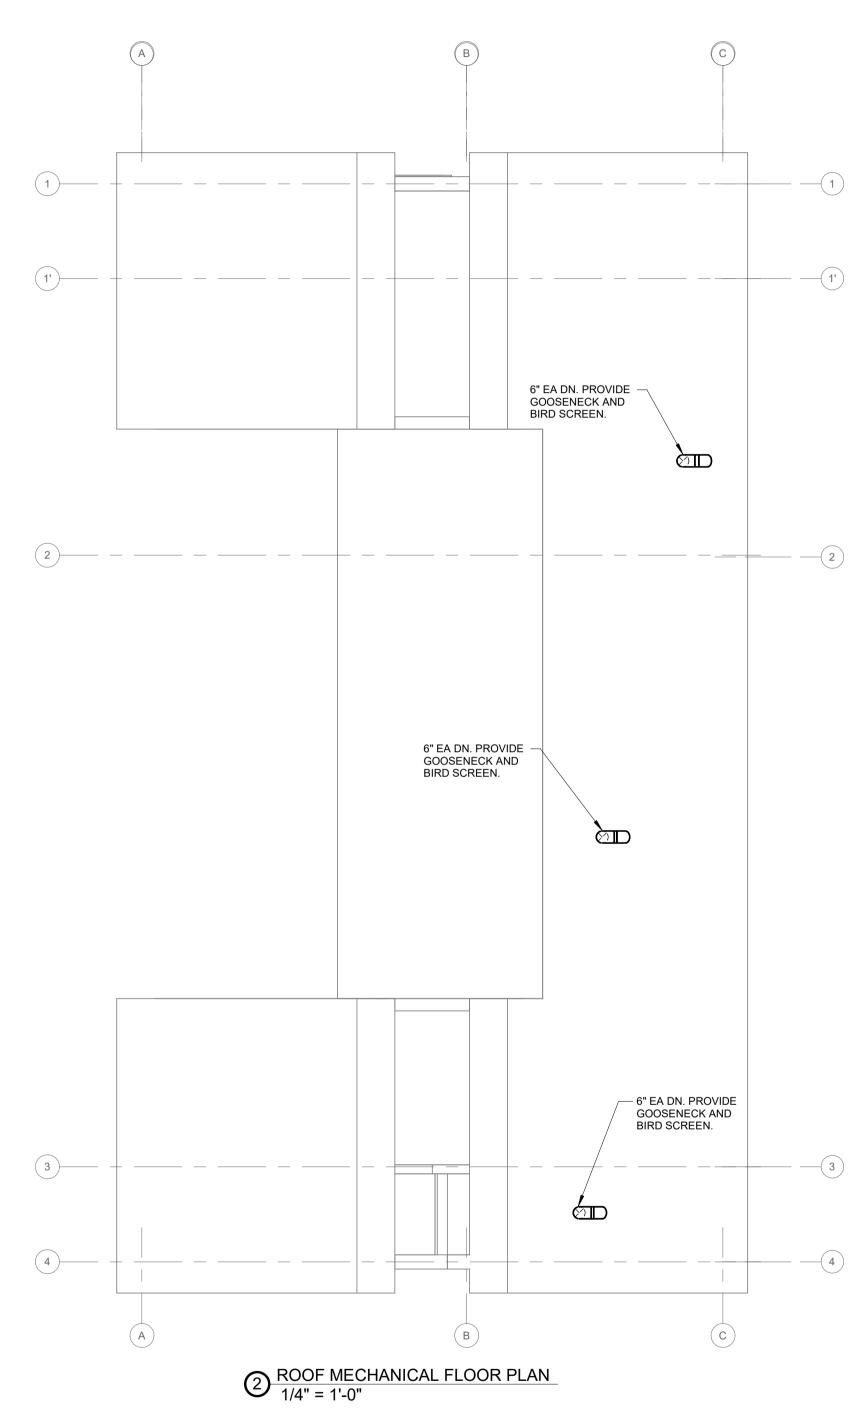

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